

A66 Northern Trans-Pennine Project

Scheme 07: Bowes Bypass

TR010062

5.18 Engineering Section Drawings (Cross Sections) (Rev 2)


APFP Regulations 5(2)(o) and 6(2)


Planning Act 2008

Infrastructure Planning (Applications: Prescribed Forms and Procedure) Regulations 2009

Deadline 7

09 May 2023

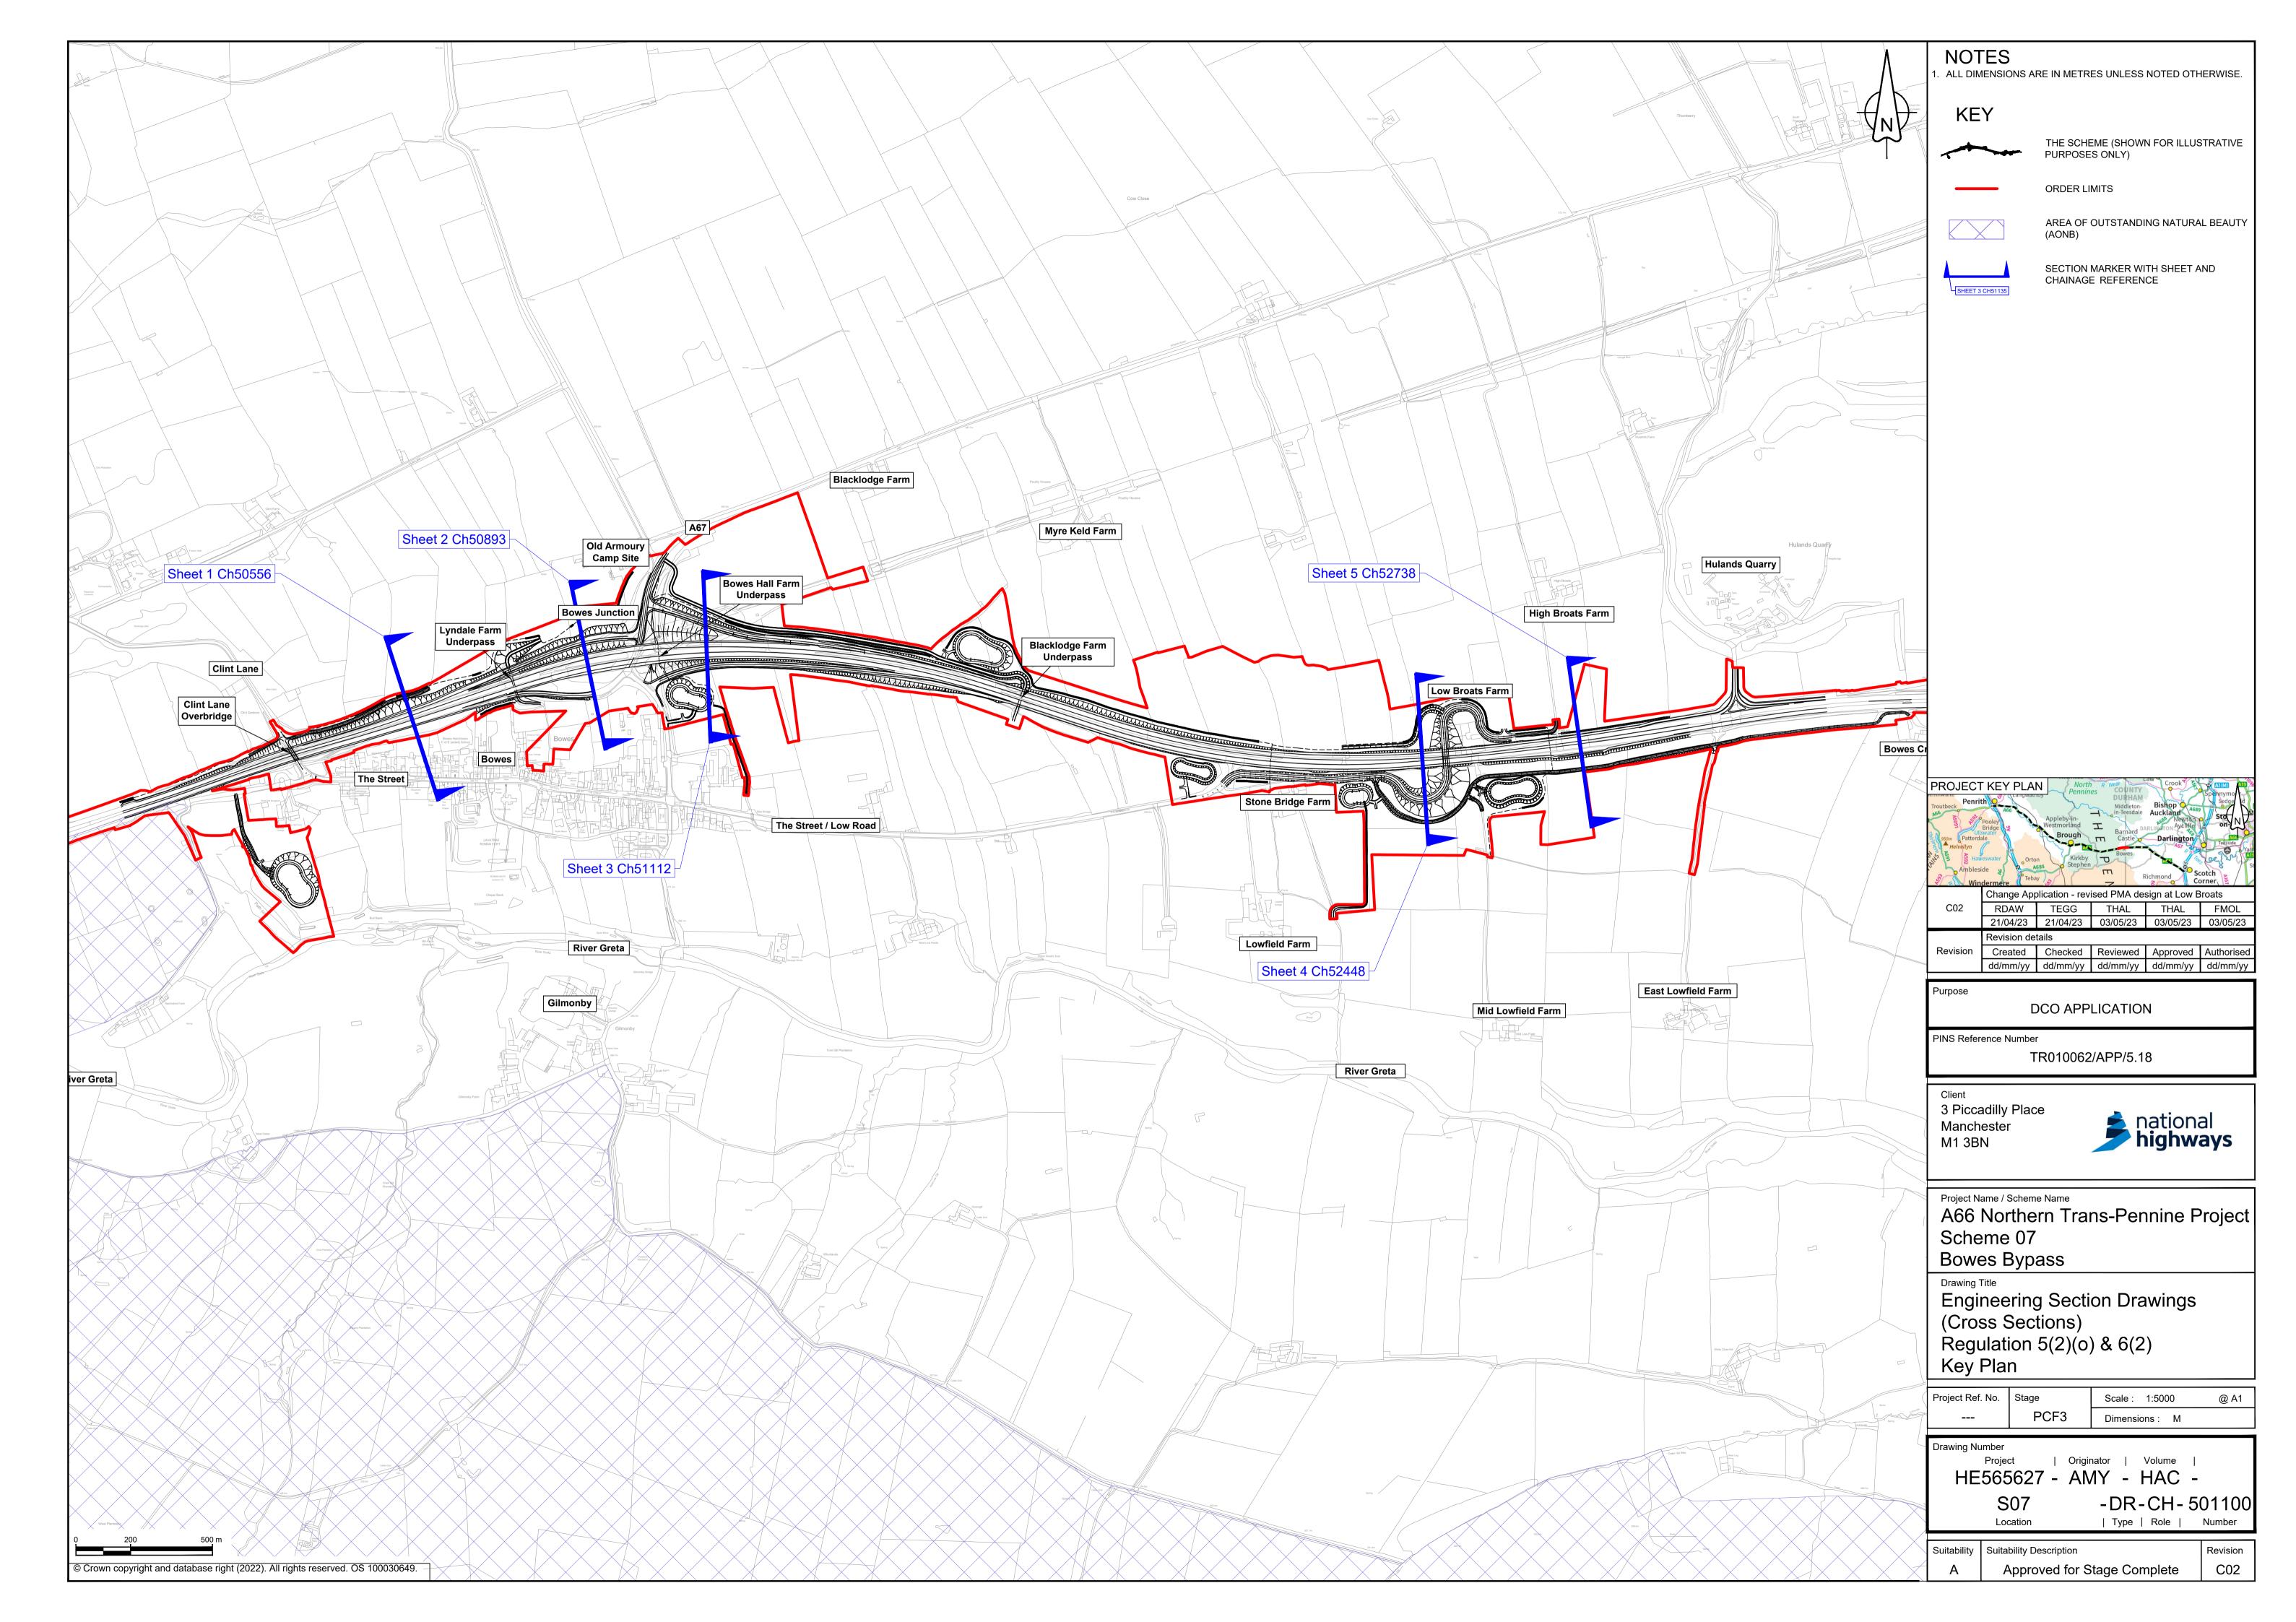

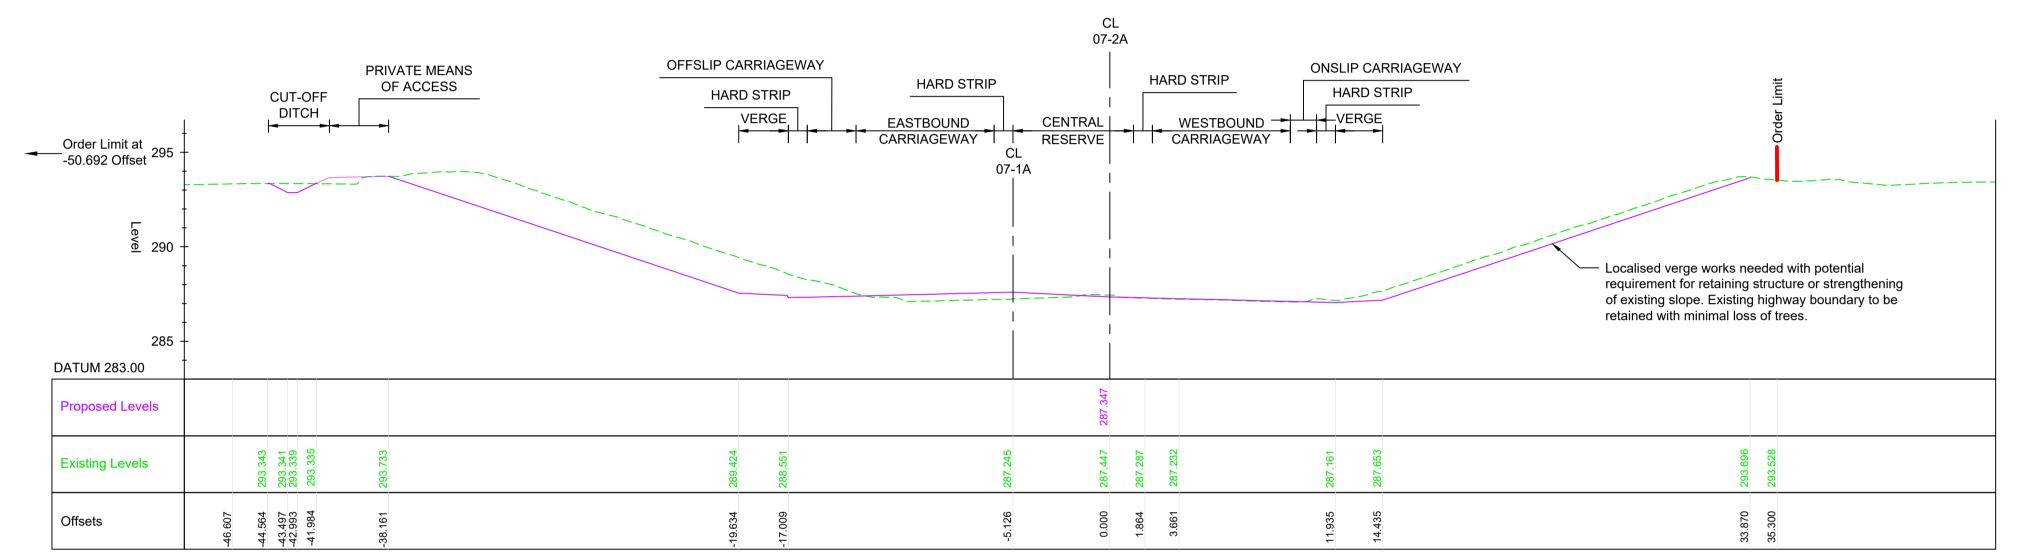

TYPICAL SECTION CH 50556 WORK NO. 07-2A

SCALE 1:200

NOTES

. ALL DIMENSIONS ARE IN METRES UNLESS NOTED

- OTHERWISE.

 2. THESE ENGINEERING SECTION DRAWINGS SHOULD BE READ IN CONJUNCTION WITH THE KEY PLAN AND ALONGSIDE OTHER PLANS AND DOCUMENTS IN THE DEVELOPMENT CONSENT ORDER APPLICATION, IN PARTICULAR, THE WORKS PLANS AND SCHEDULE 1 (AUTHORISED DEVELOPMENT) TO THE DEVELOPMENT CONSENT ORDER.
- 3. FOR CHAINAGE PLEASE REFER TO THE ENGINEERING SECTION DRAWINGS (PLAN AND PROFILES).
- WORK No. REFERENCES ARE DETAILED IN THE SCHEDULE 1 (AUTHORISED DEVELOPMENT) TO THE DEVELOPMENT CONSENT ORDER.
- 5. THE DESIGN SHOWN ON THESE ENGINEERING SECTION DRAWINGS IS ILLUSTRATIVE AND WILL BE SUBJECT TO THE DETAILED DESIGN DEVELOPMENT; ANY CHANGES WILL BE LIMITED TO BEING WITHIN THE ORDER LIMITS AND ANY OTHER CONSTRAINTS INCLUDED IN THE DEVELOPMENT CONSENT ORDER.

KEY

PROPOSED LEVEL

---- EXISTING LEVEL

ORDER LIMITS

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Purpose

DCO APPLICATION

Revision Created Checked Reviewed Approved Authorised dd/mm/yy dd/mm/yy dd/mm/yy dd/mm/yy dd/mm/yy

PINS Reference Number

TR010062/APP/5.18

Client
3 Piccadilly Place
Manchester
M1 3BN



Project Name / Scheme Name

A66 Northern Trans-Pennine Project Scheme 07

Bowes Bypass

Engineering Section Drawings (Cross Sections)
Regulation 5(2)(0) & 6(2)
Sheet 1 of 5

Project Ref. No. Stage Scale: 1:200 @ A1

PCF3 Dimensions: M

Drawing Number

Project | Originator | Volume | HE565627 - AMY - HAC -


S07 - DR - CH - 501101

Location | Type | Role | Number


Suitability Suitability Description Revision

A Approved for Stage Complete C01

5 10 m

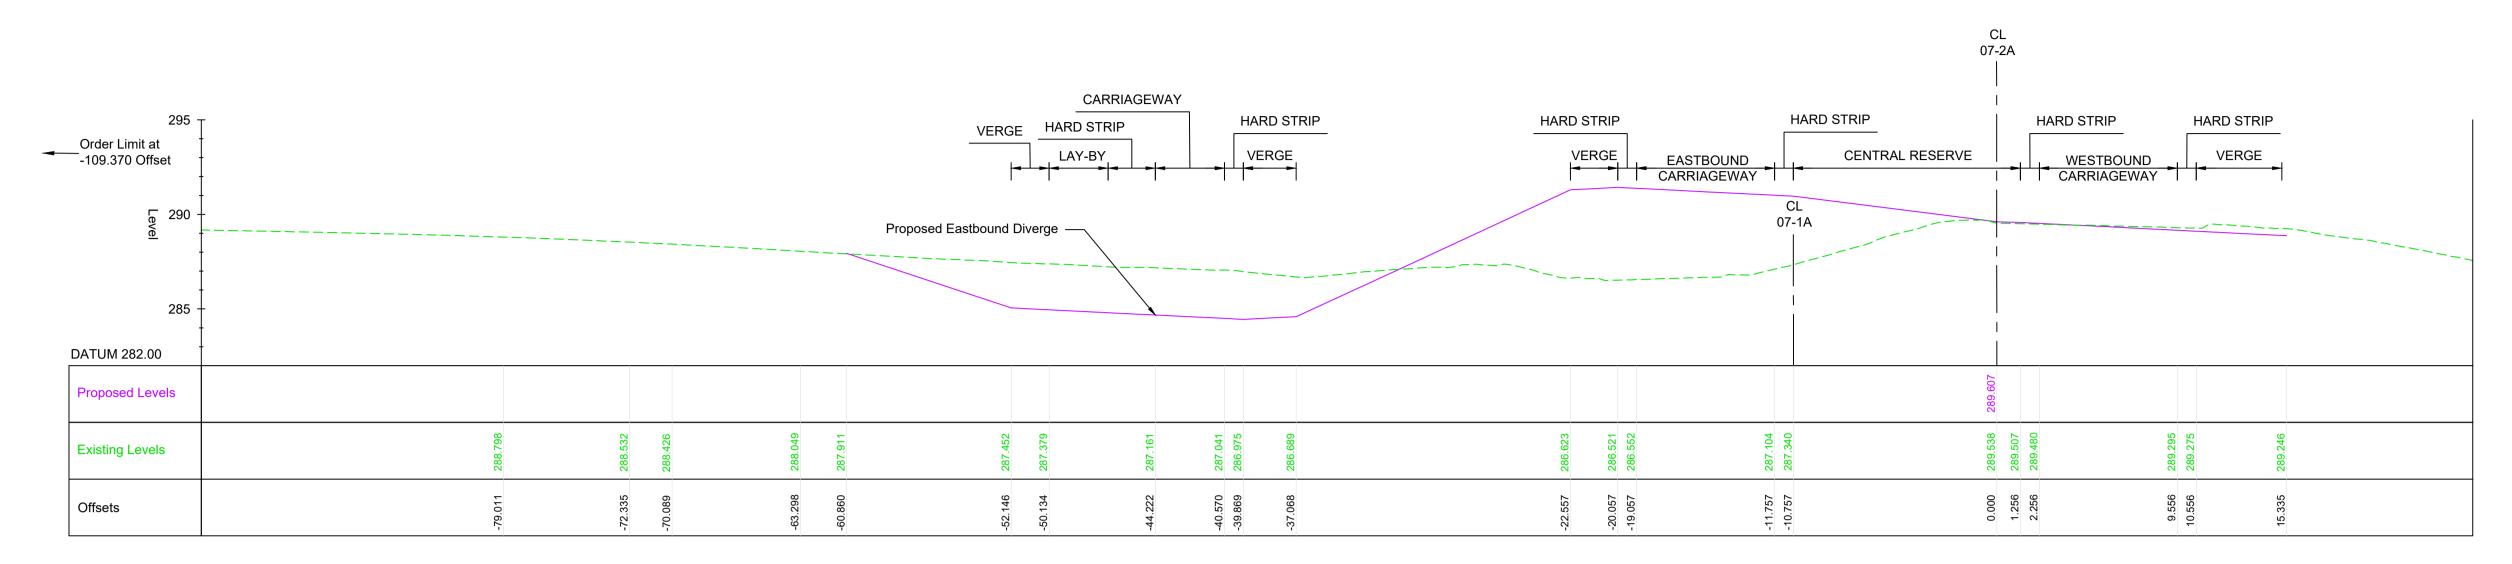

TYPICAL SECTION CH 50893 WORK NO. 07-2A SCALE 1:200

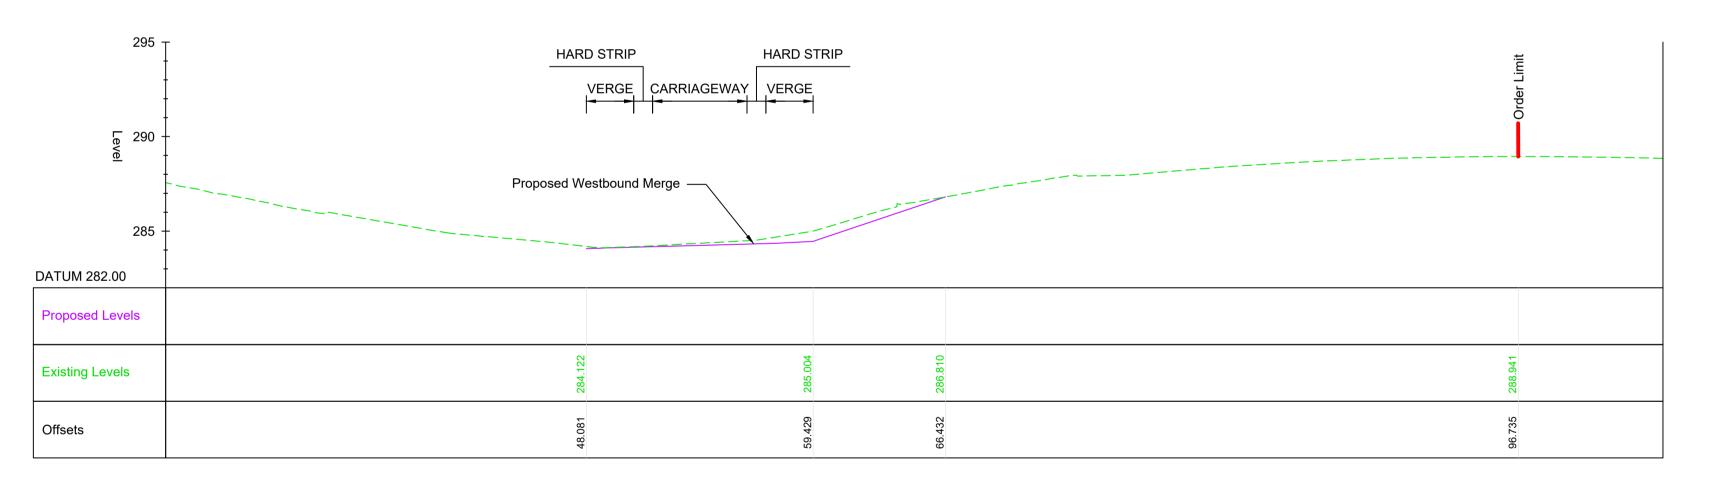

TYPICAL SECTION CH 50893 (CONT.) WORK NO. 07-2A
SCALE 1:200

NOTES

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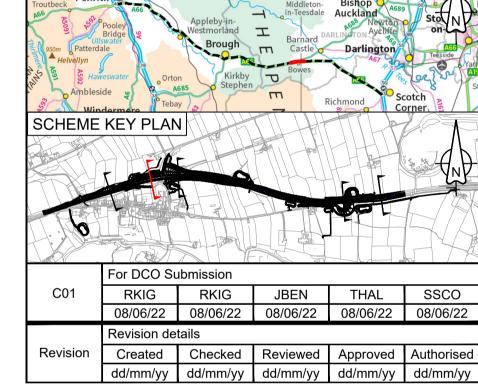


PROPOSED LEVEL

PROJECT KEY PLAN

EXISTING LEVEL

ORDER LIMITS



Purpose

DCO APPLICATION

PINS Reference Number

TR010062/APP/5.18

Client
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M1 3BN



A66 Northern Trans-Pennine Project
Scheme 07

Bowes Bypass

Engineering Section Drawings (Cross Sections)
Regulation 5(2)(0) & 6(2)
Sheet 2 of 5

Project Ref. No.	Stage	Scale : 1:200	@ A1
	PCF3	Dimensions : M	

Drawing Number Project

Project | Originator | Volume | HE565627 - AMY - HAC -


S07 - DR-CH- 501102

Location | Type | Role | Number


Suitability Suitability Description Revision

A Approved for Stage Complete C01

5 10 m

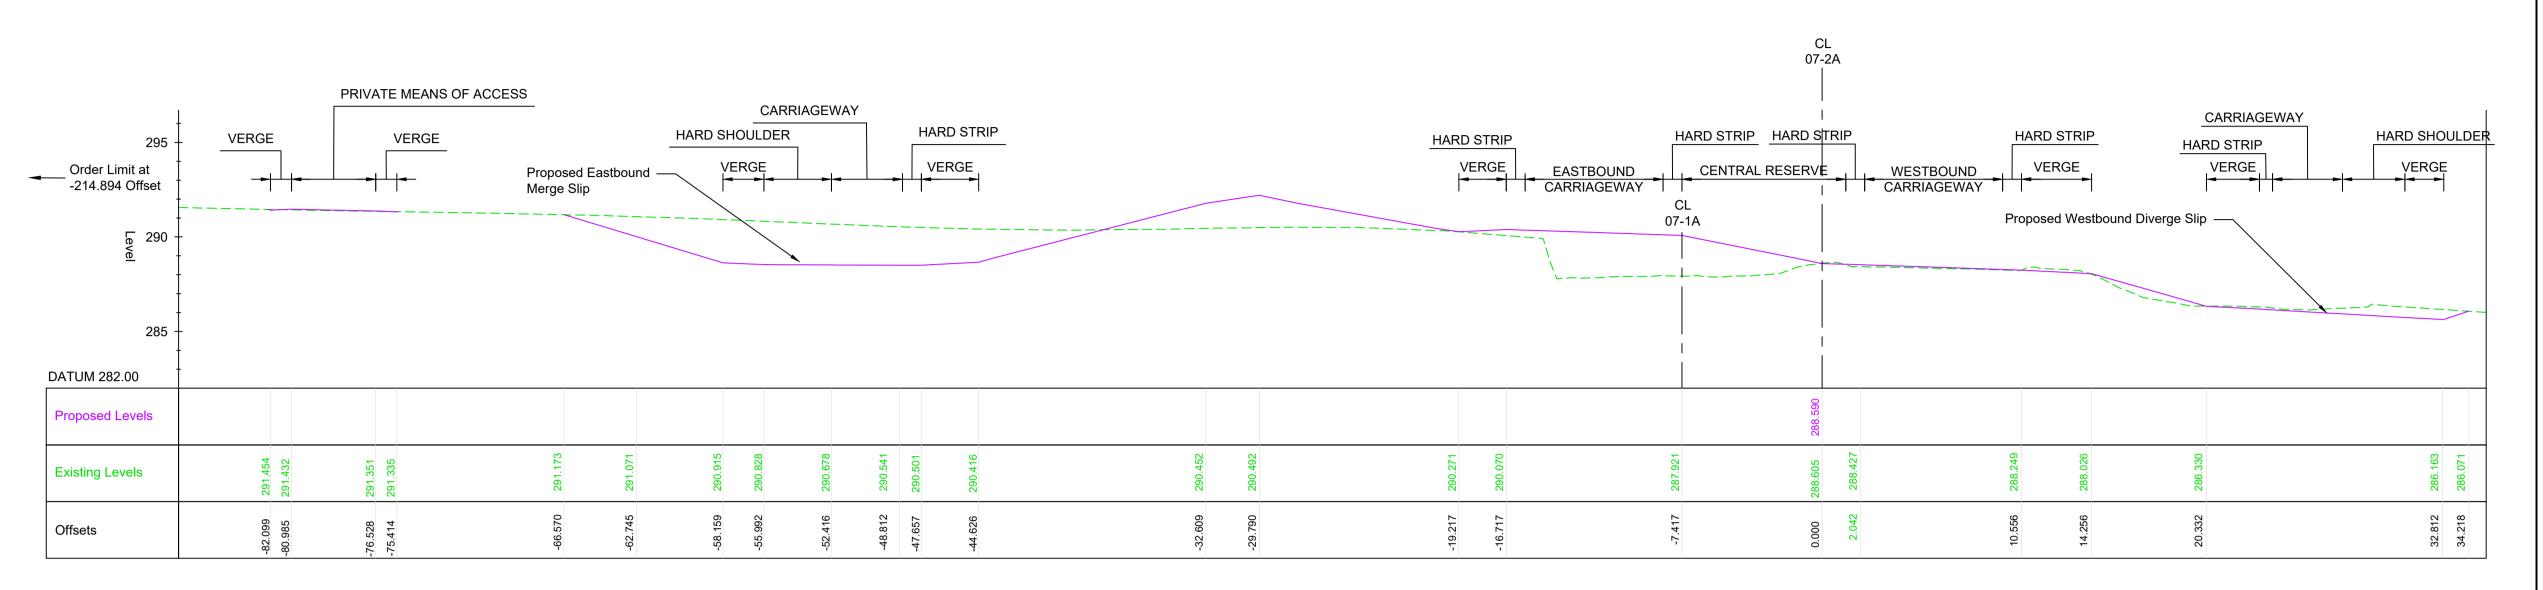

TYPICAL SECTION CH 51112 WORK NO. 07-2A SCALE 1:200

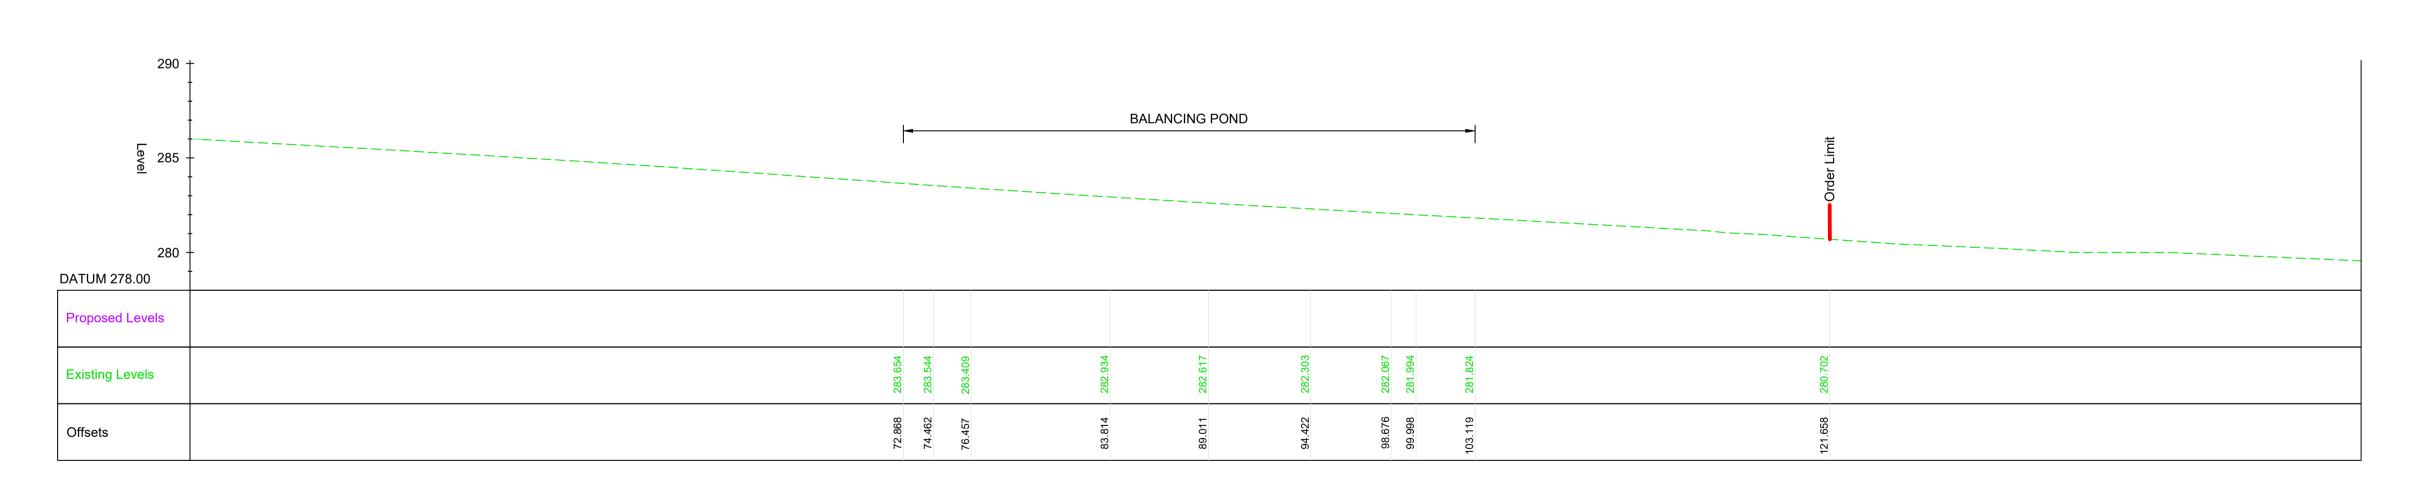

TYPICAL SECTION CH 51112 (CONT.) WORK NO. 07-2A

NOTES

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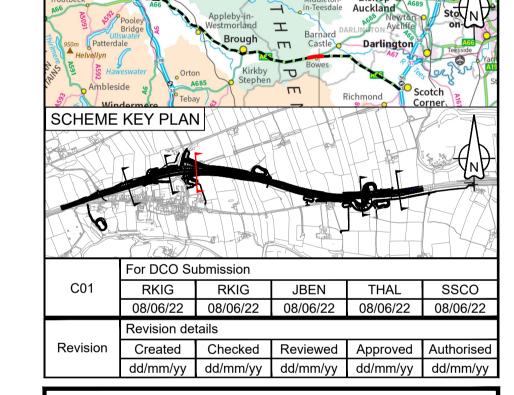
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PINS Reference Number

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Client
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PROJECT KEY PLAN



Project Name / Scheme Name

A66 Northern Trans-Pennine Project Scheme 07

Bowes Bypass

Drawing Title

Engineering Section Drawings (Cross Sections)
Regulation 5(2)(0) & 6(2)

Sheet 3 of 5

Project Ref. No.	Stage	Scale : 1:200	@ A1
	DCE3	Dimensions : M	

Drawing Number


Project | Originator | Volume | HE565627 - AMY - HAC -

S07 Location -DR-CH-501103 | Type | Role | Number


Suitability Suitability Description Revision

A Approved for Stage Complete C01

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TYPICAL SECTION CH 52448 WORK NO. 07-2B

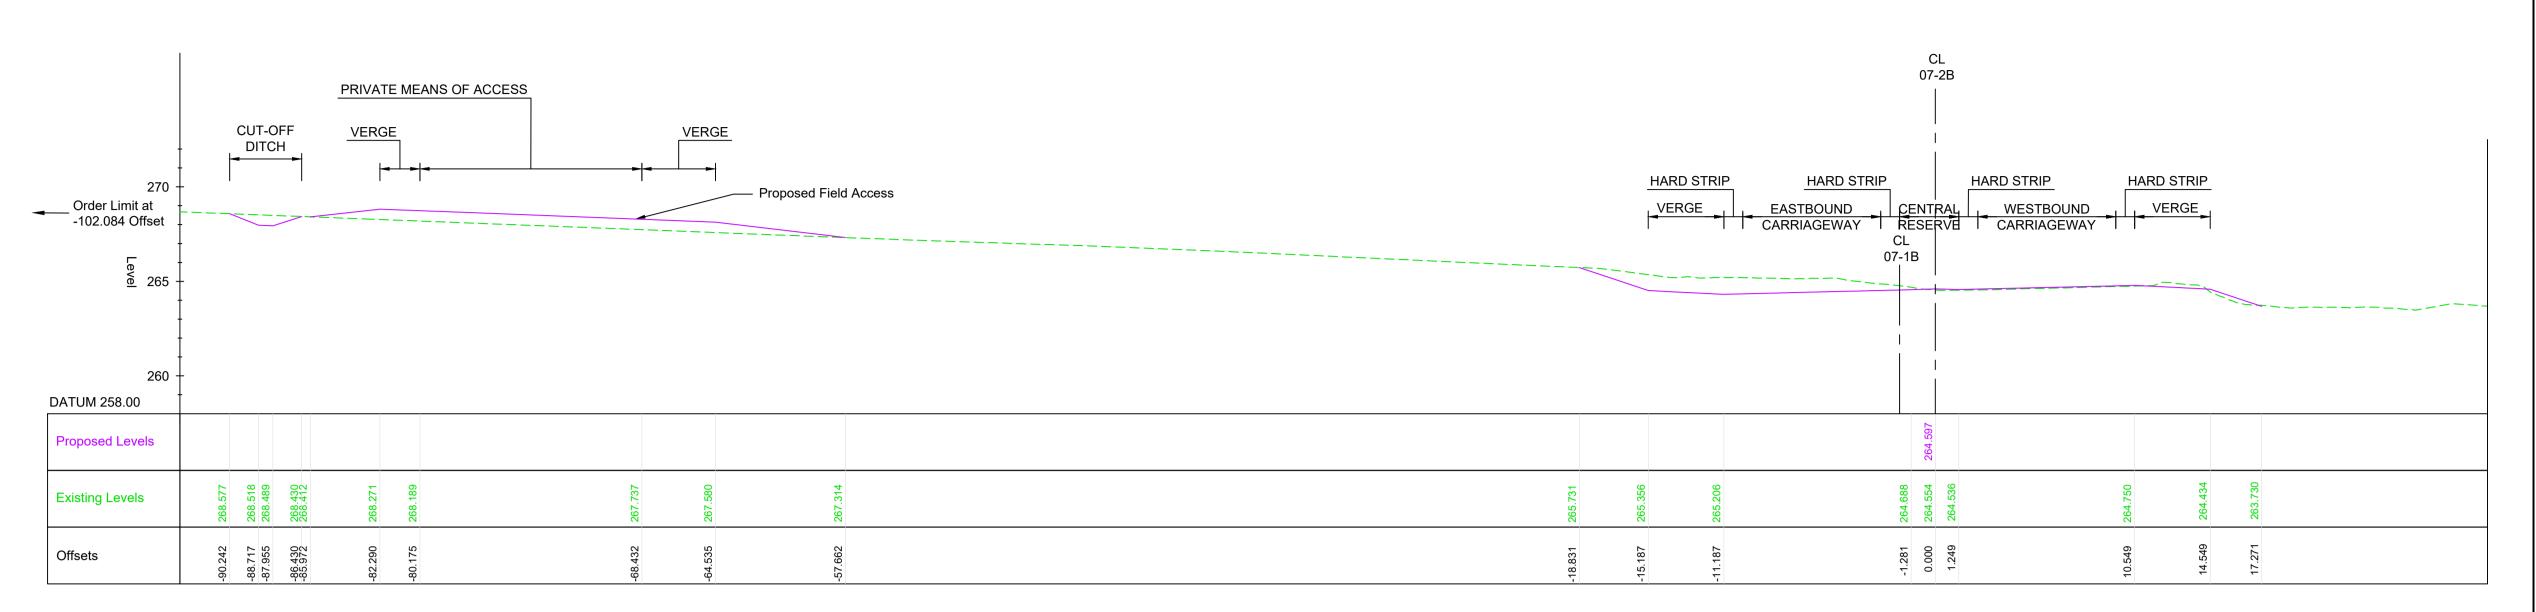

TYPICAL SECTION CH 52448 (CONT.) WORK NO. 07-2B

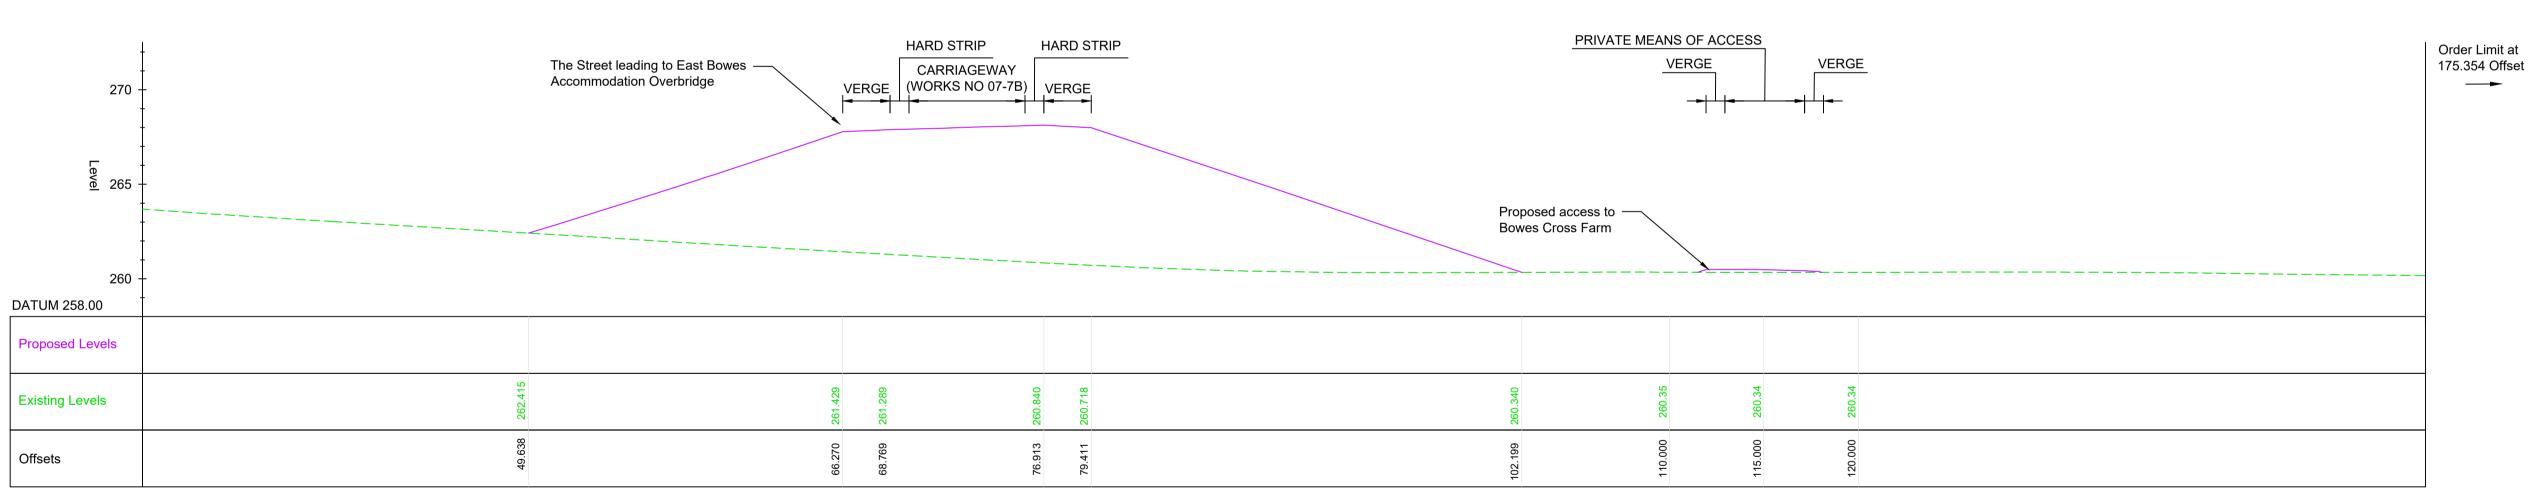NOTES

CONSENT ORDER.


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PROJECT KEY PLAN

PROPOSED LEVEL

EXISTING LEVEL

ORDER LIMITS

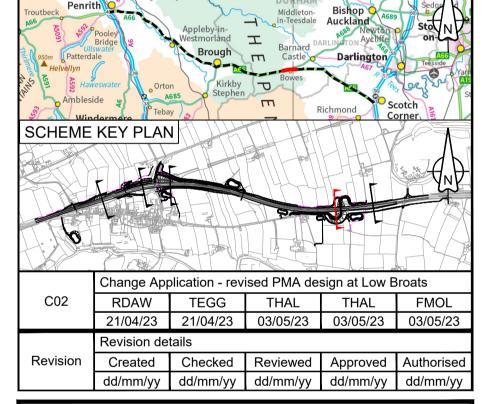

Purpose DCO APPLICATION PINS Reference Number TR010062/APP/5.18

3 Piccadilly Place Manchester M1 3BN



Project Name / Scheme Name A66 Northern Trans-Pennine Project Scheme 07 **Bowes Bypass**

Engineering Section Drawings (Cross Sections) Regulation 5(2)(o) & 6(2)

Project Ref. No.	Stage	Scale: 1:200	@ A1
	PCF3	Dimensions : M	


Drawing Number

Sheet 4 of 5

| Originator | Volume | HE565627 - AMY - HAC -

-DR-CH-501104 Location | Type | Role |

Suitability | Suitability Description Approved for Stage Complete

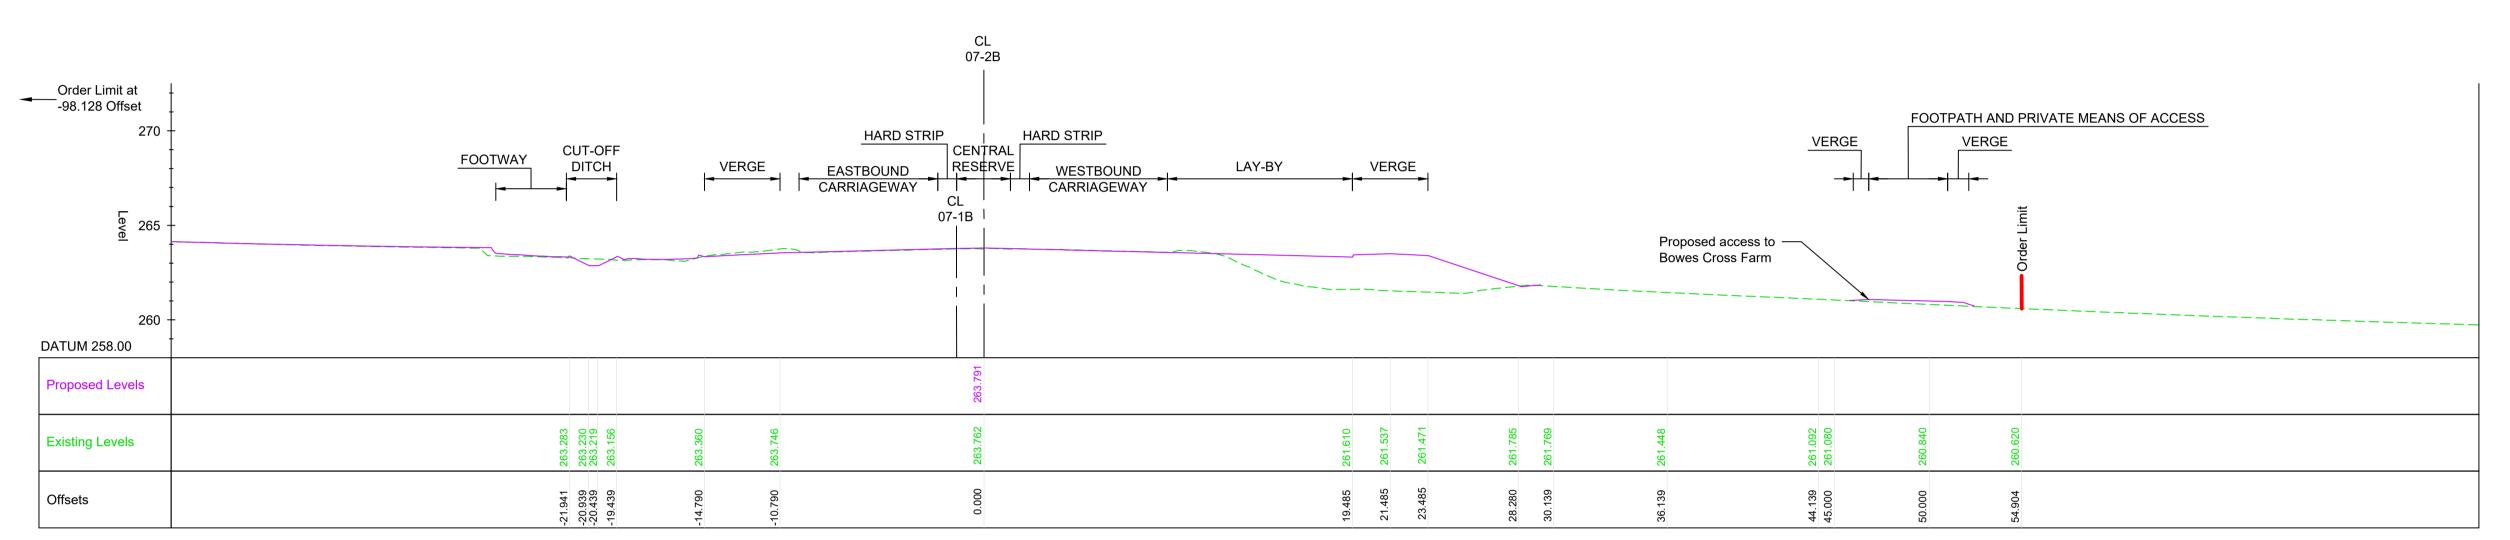

TYPICAL SECTION CH 52738 WORK NO. 07-2B
SCALE 1:200

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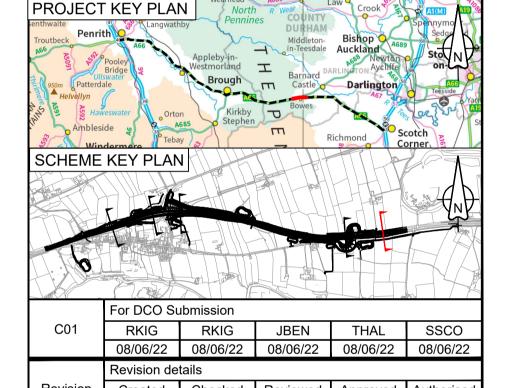
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Regulation 5(2)(0) & 6(2)
Sheet 5 of 5

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Drawing Number

Project | Originator | Volume | HE565627 - AMY - HAC -

S07 - DR - CH - 501105

Location | Type | Role | Number

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A Approved for Stage Complete C01

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